

**RESOLUTION**  
**Of the**  
**Santa Cruz County Board of Supervisors**  
**#1996-10**

**WHEREAS**, certain areas within Santa Cruz County are experiencing growth at an accelerated rate; and

**WHEREAS**, construction projects which require a building permit from Santa Cruz County are usually for residential and commercial construction projects which produce considerable construction debris and trash; and

**WHEREAS**, new construction sites may not have sanitary facilities available for construction workers:


**NOW, THEREFORE, BE IT RESOLVED**, the Santa Cruz County Board of Supervisors through the adoption of this resolution, establishes the following policy for construction site debris/trash and sanitary facilities.

1. The Santa Cruz County Building Inspector shall require for each building permit that is issued, a construction debris/trash containment fence with a minimum area of 10 feet by 10 feet with a height not less than 5 feet, constructed of wire mesh or other material suitable to the building inspector.
2. The Building Inspector shall require for each building permit that is issued, a portable toilet located on the construction site.
3. The Building Inspector at his/her discretion, may authorize an exemption to the requirements of this policy when alternative acceptable debris/trash containment facilities and sanitary facilities (portable toilets) are available.
4. For any building permit issued after the effective date of this policy, the Santa Cruz County Building Inspector shall issue a cease and desist order to the holder of any building permit which is not in compliance with this policy.

**NOW, THEREFORE BE IT FURTHER RESOLVED**, the policy established by this resolution becomes effective 30 days from this date.

**PASSED AND ADOPTED** by the Santa Cruz County Board of Supervisors, this 6<sup>th</sup> day of February, 1996.



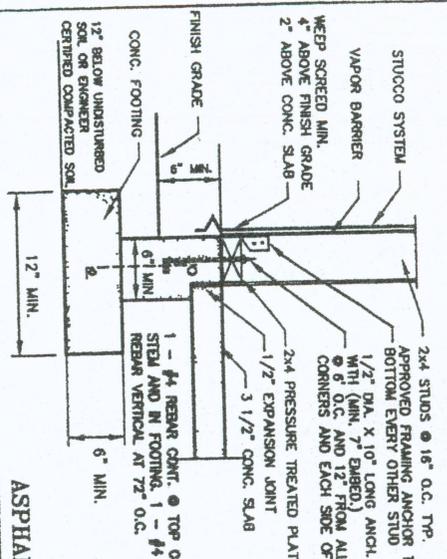


**1 EXTERIOR WALL FOOTING**  
 ATTENATE: MONOLITHIC FOOTING  
 ASK FOR DETAILS

**ASPHALT SHINGLES:**


ONE (1) LAYER OF TYPE 15 FELT SHALL BE APPLIED SHINGLE FASHION (OVERLAPPING) PRIOR TO THE INSTALLATION OF THE SHINGLES. SHINGLES SHALL BE FASTENED ACCORDING TO MANUFACTURER'S INSTRUCTIONS. EXCEPT THAT THE FOLLOWING NUMBER OF NAILS SHALL BE USED:

- SELF-SEALING TYPE SHINGLES -- 4 NAILS PER 36-INCH STRIP.
- STANDARD 3-TAB SHINGLES -- 6 NAILS PER 36-INCH STRIP.
- INDIVIDUAL SHINGLES LESS THAN 18" WIDE -- 2 NAILS PER SHINGLE.

NAILS OR STAPLES USED TO FASTEN ASPHALT SHINGLES SHALL MEET OR EXCEED THE MANUFACTURER'S RECOMMENDATIONS AND SHALL MEET THE MINIMUM PROPERTY STANDARDS. A. SHALL BE GALVANIZED OR CORROSION RESISTANT METAL. B. SHALL BE LONG ENOUGH TO PENETRATE THE ROOFING MATERIAL AND AT LEAST 3/4" INTO THE WOOD DECK SHEATHING OR THRU THE SHEATHING.

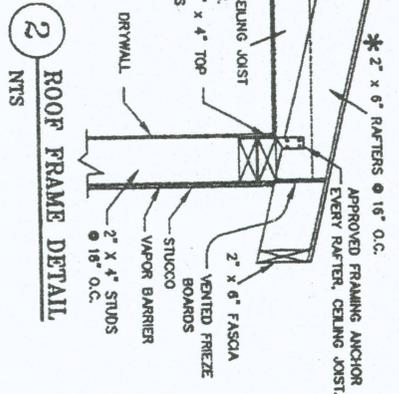

**2 ROOF FRAME DETAIL**  
 NTS

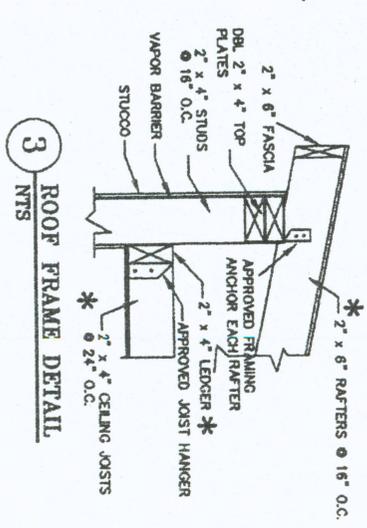




**3 ROOF FRAME DETAIL**  
 NTS


**LATERAL BRACING REQUIREMENTS:**

ALL EXTERIOR WALLS AND MAIN CROSS-STUD PARTITIONS SHALL BE EFFECTIVELY AND THOROUGHLY BRACED AT EACH END, OR AS NEAR THERE TO AS POSSIBLE AND AT LET EVERY 25 FEET OF LENGTH BY ONE OF THE FOLLOWING METHODS:

- 1** NORMAL 1 X 4 CONTINUOUS DIAGONAL BRACES LET AND TOP AND BOTTOM PLATES AND INTERVENING STUDS, PLACED AT AN ANGLE APPROXIMATELY 45 DEGREES FROM THE HORIZONTAL AND ATTACHED TO THE FRAMING WITH 2-6d NAILS AT PLATES AND STUDS.
- 2** WHEN DIAGONAL BRACING CAN NOT BE INSTALLED PROVIDE 3/8 INCHES THICK PLYWOOD PANEL, 48 INCHES WIDE, COVERING 3 STUD SPACES NAIL WITH 8d @ 8" O.C. @ EDGES, 12" O.C. AT INTERMEDIATE SUPPORTS.


\* RAFTER JOIST AND LEDGER SIZES WILL VARY DEPENDING ON SPAN AND ROOF LOADING.

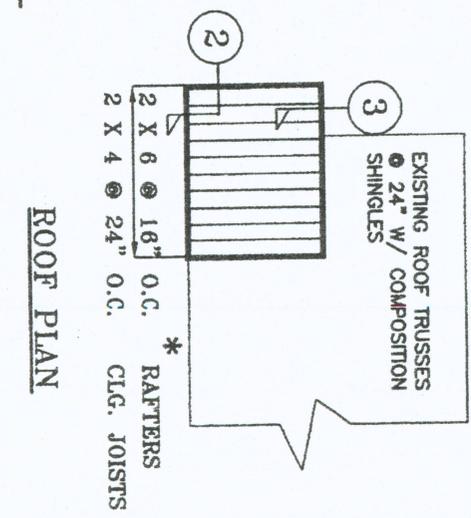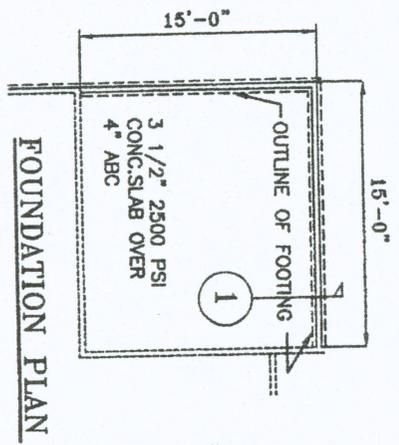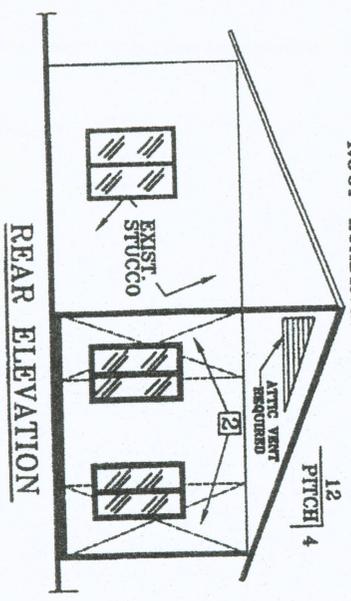

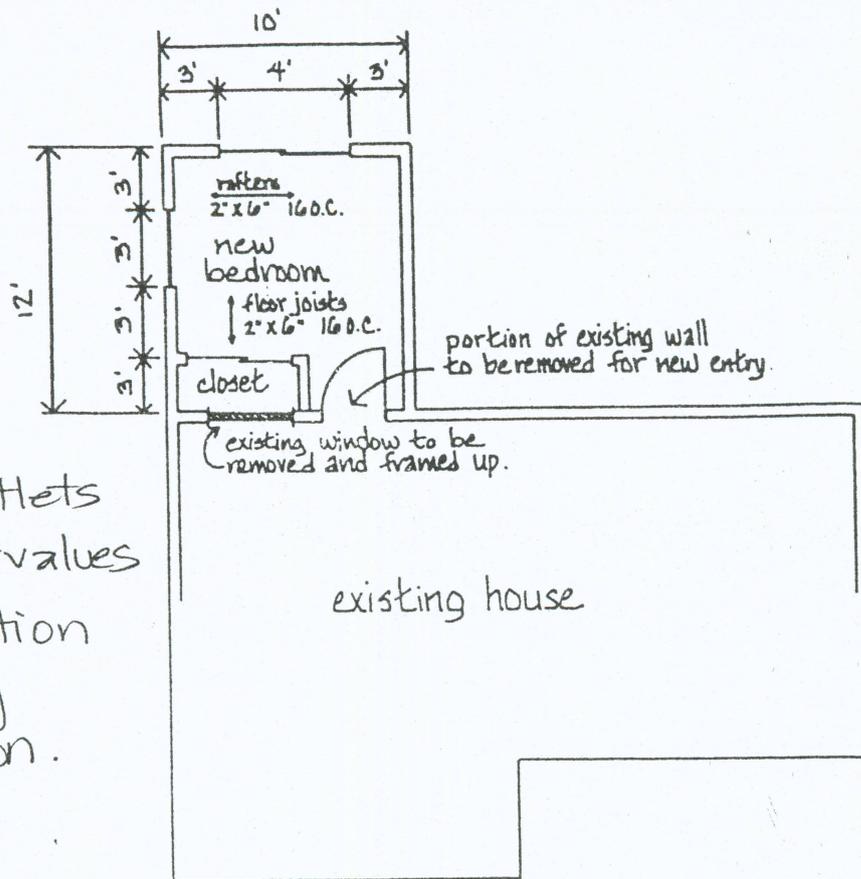


- show all outlets
- window U-values
- name portion of existing construction.

FLOOR PLAN not to scale

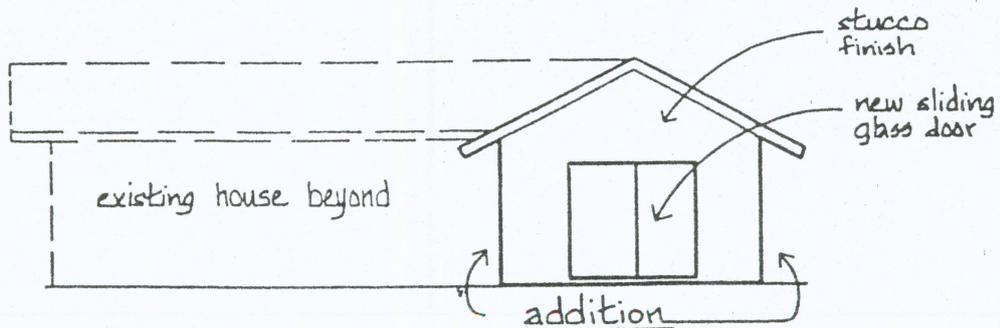

ELEVATION not to scale


FOR BLOCK

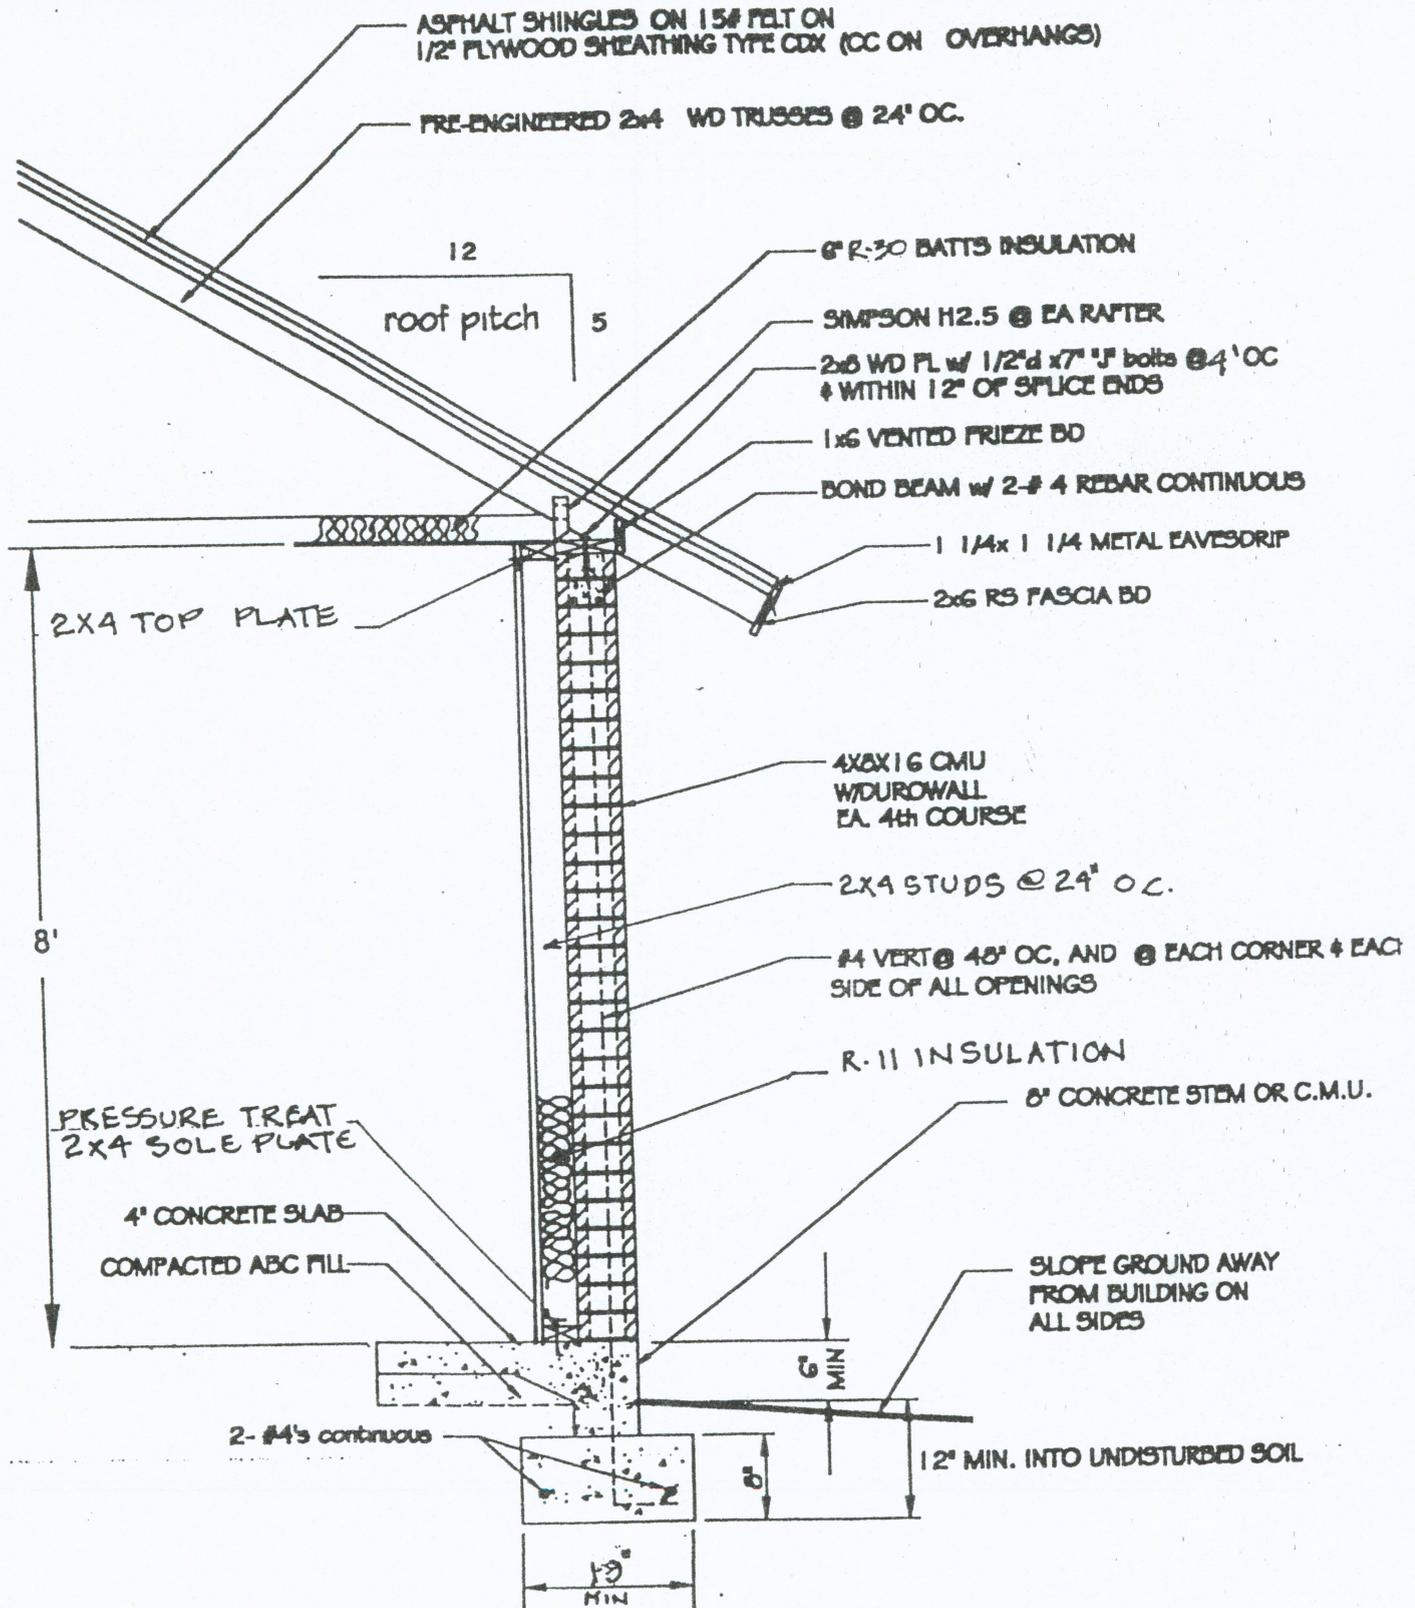

[SAMPLE] CROSS-SECTION

not to scale


# FOR FRAME STUCCO

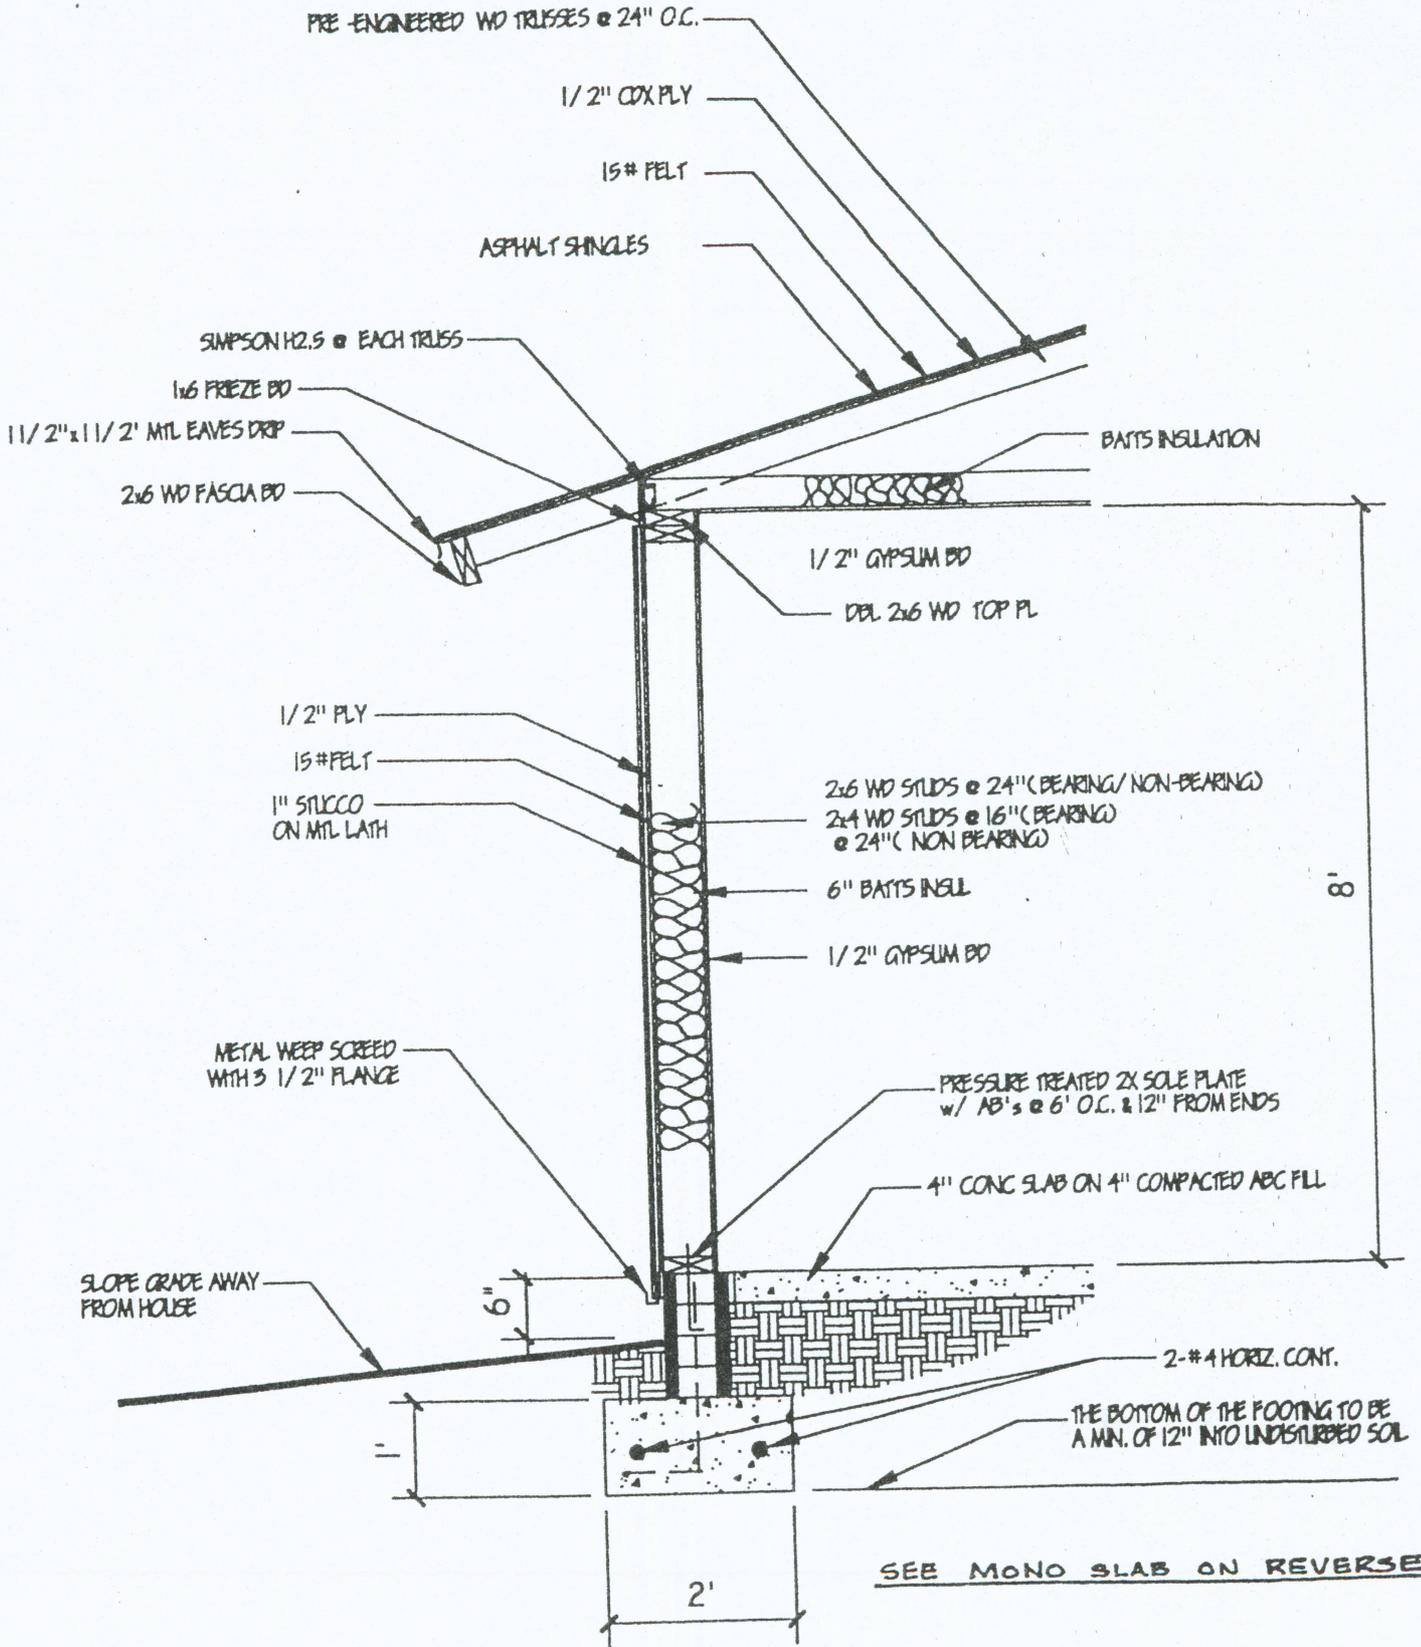

TYPICAL 2x WALL SECTION

SCALE: NOT TO SCALE

SAMPLE

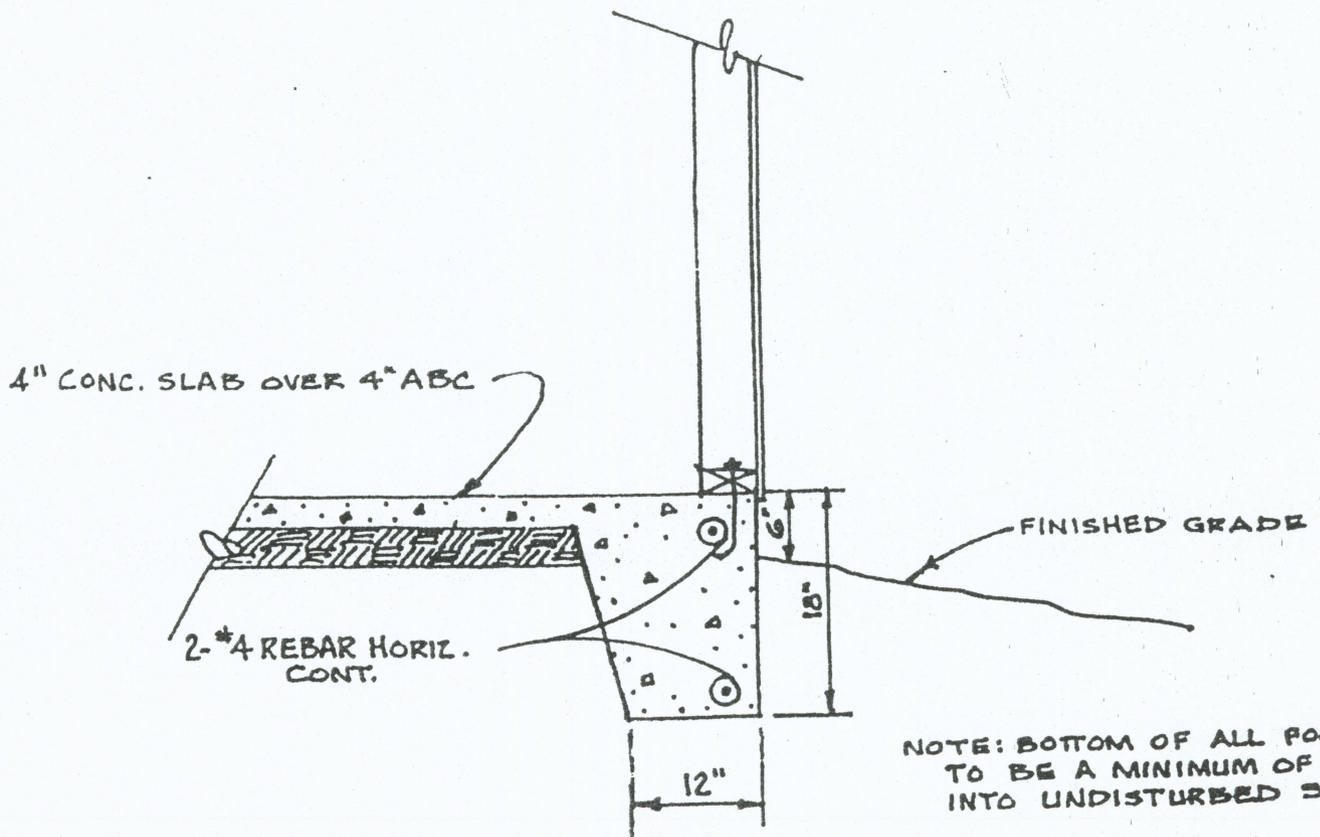


SAMPLE

# PANEL SCHEDULE

200 AMP M.B.

DESTINATION	CIR	BRKR	AWG	AWG	BRKR	CIR	DESTINATION
HP-1	1	50 2P	4 AL 6 CU	6-3 W/GND. 4 AL	50 2P	2	RANGE & OVEN
	3					4	
WATER HEATER	5	30 2P	10-3 CU	10-3 CU W/GND.	30 2P	6	DRYER
	7					8	
SPARE	9					10	SPARE
	11					12	
WASHER	13	20 1P	122 CU	142 CU	15 1P	14	LTS. ONLY
D/W-DISP.	15					16	LTS. & RECEPTS.
KITCHEN (GFCI)	17					18	
KITCHEN (GFCI)	19					20	
REF.	21					22	
GREAT RM.	23					24	
DINING	25					26	
GARAGE GFCI	27					28	
EXT. GFCI RECEPTS.	29					30	SMOKE DETECTOR
UTILITY (GFCI)	31					32	SPARE
FURNACE	33					34	
BATH GFCI	35					36	
	37					38	
SPARE	39					40	

Original

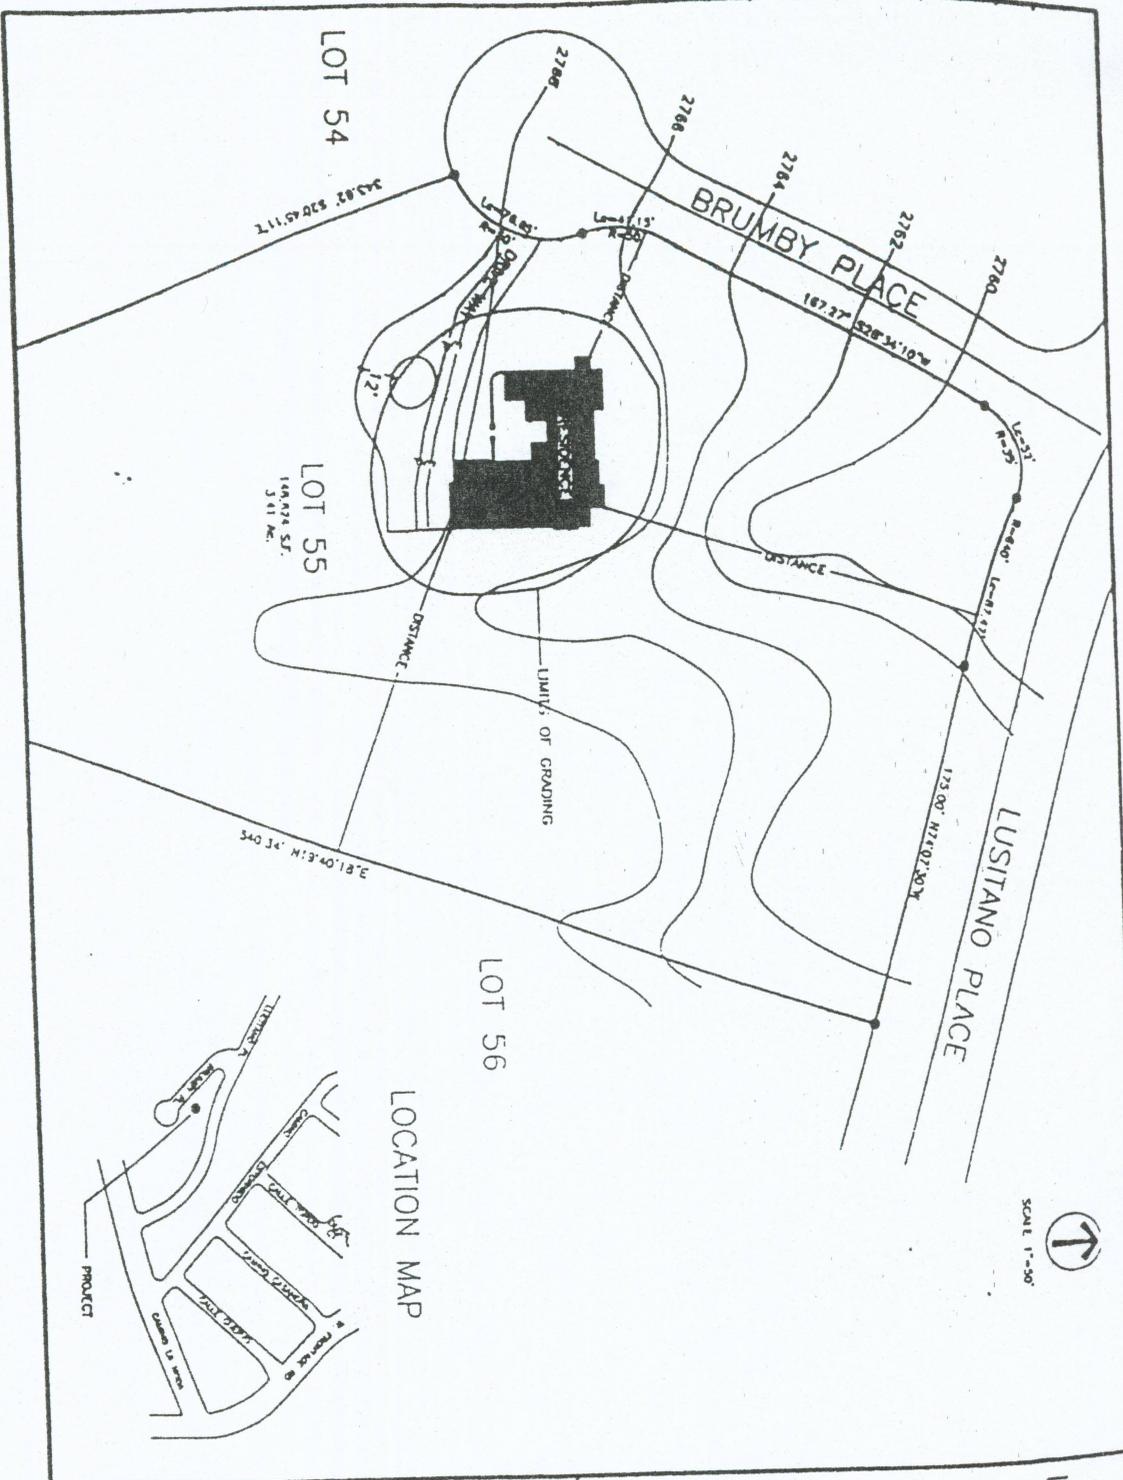

**GENERAL NOTES:**

**LEGEND:**  
 LOCATION OF THE LINES  
 LOCATION OF SPOT SW.  
 STREET LOCATION  
 LOCATION OF CORNER PROPERTY  
 EXISTING CONTOUR LINE  
 PROPOSED CONTOUR LINE

**LEGAL DESCRIPTION:**  
 LOT #  
 BLOCK #  
 SUBDIVISION  
 PARCEL #  
 STREET ADDRESS  
 DIMENSION OF PROPERTY LINE  
 AREA OF THE PARCEL  
 ZONING OF THE PROPERTY

**EARTH WORK**  
 SHOW LIMITS OF GRADING AND LIST MAX. DEPTH OF ANY CUTS AND/OR FILLS  
 TOTAL CUT  
 TOTAL FILL  
 HYDROSEED ON CUTS & FILLS

**SAMPLE PLOT PLAN**  
 OWNER'S NAME OR CONTRACTOR NAME  
 ADDRESS  
 PHONE

**REVISION:**

NO.	DATE	DESCRIPTION

**SHEET NUMBER**

Site plan requirements:

- drawn on 11" X 17" paper
- scale - 1" = 20'

# **\*NOTICE\***

**EFFECTIVE SEPT. 1<sup>ST</sup>, 2004:**

**ALL PERMIT SUBMITTALS WILL BE REQUIRED TO HAVE A RIGHT OF WAY PERMIT FOR DRIVEWAY TIE-IN TO COUNTY ROADS FROM PUBLIC WORKS, IN ORDER FOR THE APPLICATION TO BE ACCEPTED.**

**EXCEPTION: BUILDING TO HAVE ACCESS FROM A PRIVATE ROAD OR STATE-ROAD HIGHWAY.**

**CONTACT NORMA NORTHCROSS, PUBLIC WORKS, ROOM 117, OR CALL 375-7830.**

**EXAMPLE DRAWINGS**  
**(FOR REFERENCE ONLY)**